



North East Elevation
SCALE 1:500

ELEVATION - Part 1

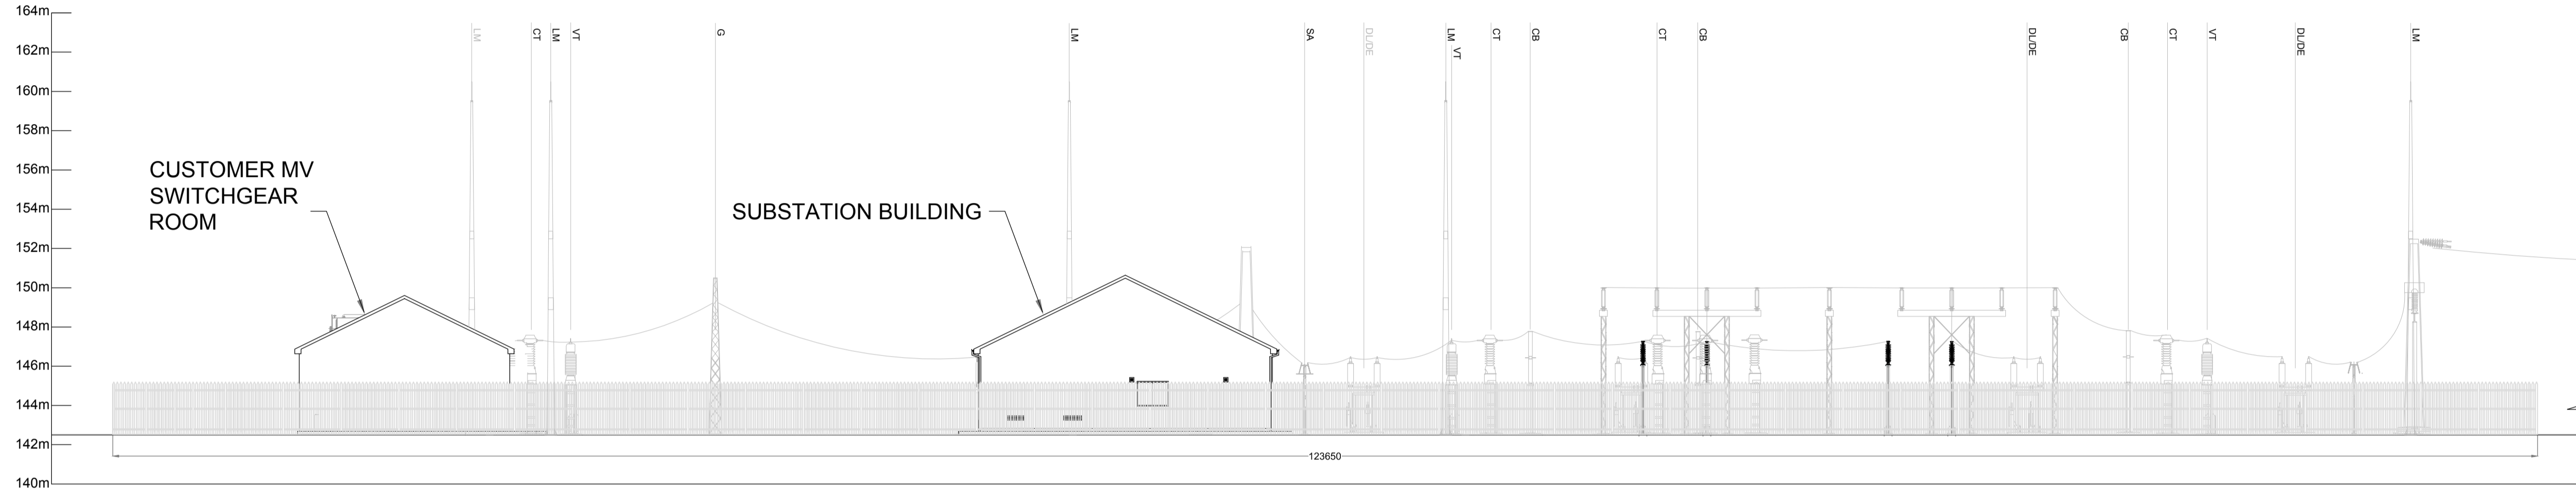

North East Elevation
SCALE 1:200

ELEVATION - Part 2

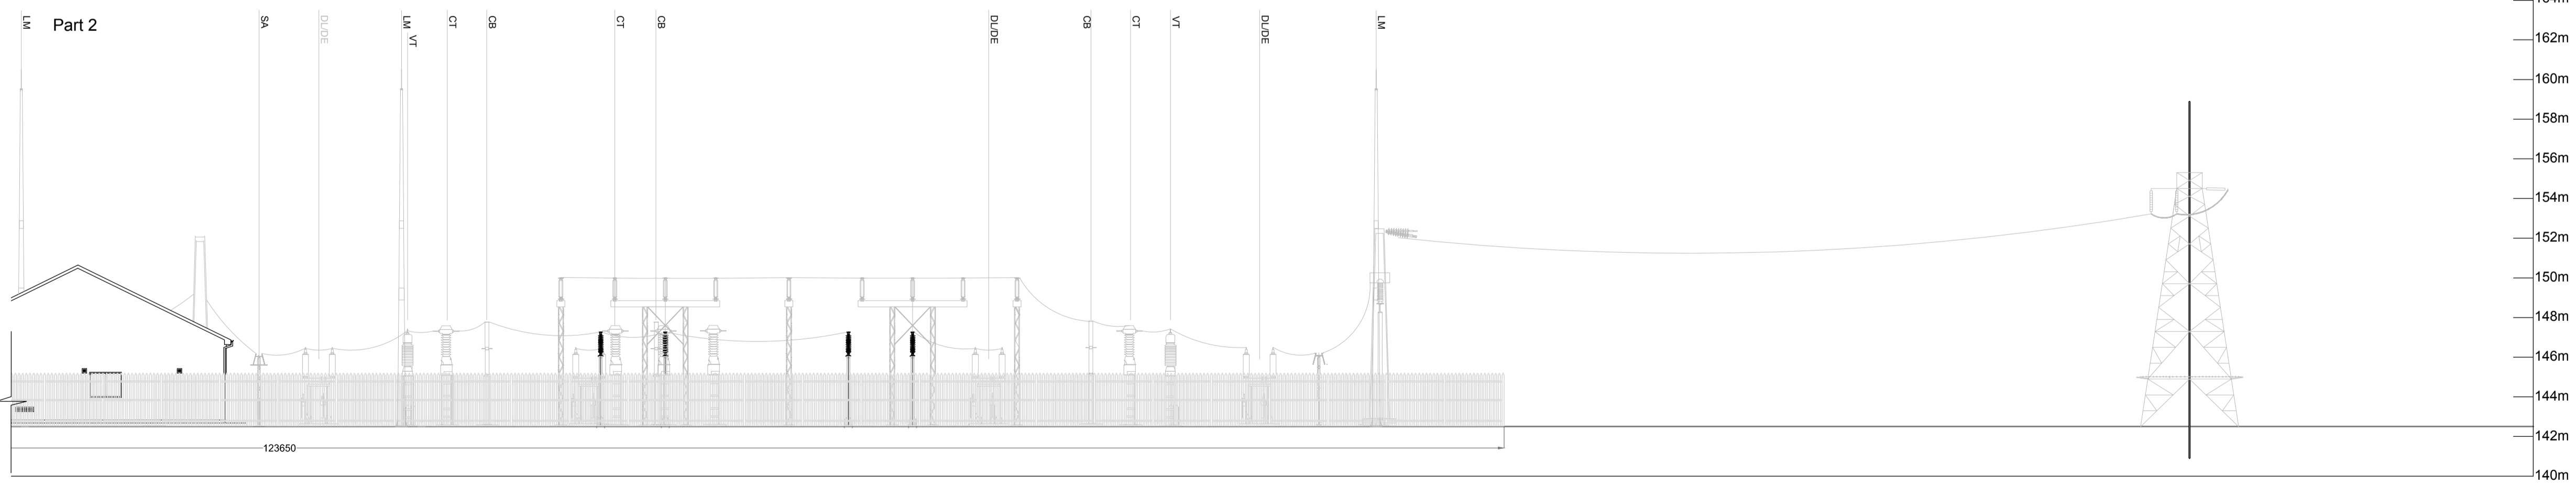

North East Elevation
SCALE 1:200

Project Management Initials: Designer: GD
Checked: DT
Approved: RG



- NOTES: -**
- Layout and Arrangements of Substation Building and Electrical Equipment is shown indicatively and for illustration purposes only.
 - Dimensions shown are as per current Eirgrid Specifications at the time of submission. Dimensions may vary at time of construction to reflect any revisions to Eirgrid Specifications.
 - Final Specifications of Buildings and Electrical Equipment is to be as per Eirgrid and ESB Specifications.
 - The Elevation of the Compound will be depicted by localized Topography such that Cut/Fill Earthworks associated with the construction of the Compound are balanced.

LEGEND: -

	Description
G	Gantry.
SA	Surge Arrester.
DL/DE	Line / Earth Disconnect.
DT/DEMI	Trafo / Earth Disconnect.
VT	Voltage Transformer.
CT	Current Transformer.
CB	Circuit Breaker.
DA	Busbar Disconnect.
PI	Post Insulator.
LM	Lighting Mast.

ISSUE/REVISION

NO.	DATE	DESCRIPTION
P00	15.12.20	Issued for Planning
I/R	DATE	DESCRIPTION

Drawn By : Ger Donnellan
Approved : Ruairi Geary
PROJECT NUMBER
05-664
SHEET TITLE
Loop in Substation -
Northeast Elevations
SHEET NUMBER
170749 - 24 _ (05664-DR-219)